

ASBESTOS INSPECTION REPORT

**Former Wesco Distribution Inc.
1803 Eoff Street
Wheeling, Ohio County, West Virginia**

Triad Project No. 04-15-0603

Submitted on behalf of:

West Virginia Northern Community College
1704 Market Street
Wheeling, WV 26003

Prepared
By:

Triad Engineering, Inc.
10541 Teays Valley Road
Scott Depot, West Virginia 25560

November 17, 2015

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1.0 INTRODUCTION

Triad Engineering, Inc. (Triad) was contracted by the West Virginia Northern Community College to conduct an asbestos inspection of the Property located at 1803 Eoff Street, in Wheeling, Ohio County, West Virginia. Triad conducted an inspection on November 9th, 2015 and obtained bulk samples of potential asbestos containing materials (PACMs) from the concerned areas of the subject structure, all in accordance with Title 64, Series 63 of the West Virginia Code of State Regulations and 29 CFR 1926.1101 (Occupational Safety and Health Administration's Asbestos Standard). This report presents the findings of our inspection.

Asbestos sampling was performed on accessible PACMs. Asbestos samples were placed in individual, numbered whirl packs and delivered to Pinnacle Environmental Consultants, Inc., in Hurricane, West Virginia for analysis. Copies of the state lab certifications are included in **Attachment 1** of this report, and Pinnacle laboratory analysis report is included in **Attachment 2**.

The National Emission Standards for Hazardous Air Pollutants (NESHAP) recommends that if asbestos is identified by polarized light microscopy (PLM) and the estimated quantity is less than 10% by visual estimation, the sample should be verified by Point Count Verification analysis. Point Count Verification can only be performed on material that is friable. The USEPA defines asbestos containing material (ACM) as a material that contains one percent (1%) or more asbestos fibers.

2.0 SAMPLE DESCRIPTION NARRATIVE

The property is a 27,000 square foot brick constructed warehouse structure that was formerly occupied by, Wesco Distribution. The structure has a flat asphalt roof. The building is currently vacant; however, it is anticipated to be remodeled for use by West Virginia Northern Community College. The building has a very wide open floor plan on both levels and is mostly constructed of concrete.

The building materials noted in the structure are as follows:

- FLOORING: Exposed concrete and vinyl tiles.
- WALLS: Plaster, wood paneling, and concrete.

- CEILINGS: Metal frame and acoustic drop style tiles.

- PLUMBING: Cast iron and pvc.

- WINDOWS: Older metal framed.

- HEATING SYSTEM: Roof mounted gas heat.

- ELECTRICAL: Romex.

- MAIN ROOF: Flat asphalt coated.

2.1 HOMOGENEOUS AREA TABLES

The following table lists all of the homogeneous areas inspected and sampled from the Property:

HOMOGENEOUS AREA #	DESCRIPTION	ASBESTOS YES	ASBESTOS NO	ASBESTOS PERCENT	QUANTITY
1	Roofing – rolled rubber		X		
2	Window Glazing (2nd floor)	X		3	All 2 nd floor Windows
3	Cement wall covering		X		
4	Wall plaster		X		
5	Window glazing (1st floor)	X		2-3	All 1st floor Windows
6	Blue 12"x12" VFT	X		2	~70 Sq. Ft.
7	Cream 12"x12" VFT	X		2	~180 Sq. Ft.
8	Dark 9"x9" VFT	X		3	~1,600 Sq. Ft.
9	Red 9"x9" VFT	X		3	~1,870 Sq. Ft.
10	Acoustic Ceiling Tile		X		

Bold – indicates that sample contains more than 1% asbestos.

2.2 ASBESTOS SAMPLE TABLES

The following table lists the individual sample numbers, material description, and the percentage of asbestos content detected for samples collected:

SAMPLE NO.	HOMOGENEOUS AREA	MATERIAL	LOCATION	ASBESTOS % by PLM	PERCENT ASBESTOS By POINT COUNT
001	1	Rolled Rubber	Roofing	ND	
002				ND	
003				ND	
004				ND	

SAMPLE NO.	HOMOGENOUS AREA	MATERIAL	LOCATION	ASBESTOS % by PLM	PERCENT ASBESTOS By POINT COUNT
005				ND	
006	2	Window Glazing (2nd floor)	Interior & Exterior of 2nd floor	3	
007				3	
008				3	
009	3	Cement wall covering	Main Floor	ND	
010				ND	
011				ND	
012A* & 012B*	4	Wall plaster	Main Floor	ND	
013				ND	
014A* & 014B*				ND	
015	5	Window glazing (1st floor)	Interior & Exterior of 1st floor	3	
016				2	
017				2	
018A* & 018B*	6	Blue 12"x12" VFT	Main Floor	2	
019A* & 019B*				2	
020A* & 020B*				2	
021A* & 021B*	7	Cream 12"x12" VFT	Main Floor	2	
022A* & 022B*				2	
023A* & 023B*				2	
024A* & 024B*	8	Dark 9"x9" VFT	Main Floor	3	
025A* & 024B*				3	
026				3	
027A* & 027B*	9	Red 9"x9" VFT	Main Floor	3	
028A* & 028B*				3	
029A* & 029B*				3	
030	10	Acoustic Ceiling Tiles	Main Floor	ND	
031				ND	
032				ND	

ND- not detected.

Bold – indicates that sample contains more than 1% asbestos.

* Split sample by laboratory

2.3 ASBESTOS CONTAINING MATERIAL SUMMARY TABLE

The following table lists the quantity of asbestos, location, and the percentage of asbestos content detected for samples collected at the structure located at 1803 Eoff Street.

ASBESTOS QUANTITY	MATERIAL DESCRIPTION LOCATION	ASBESTOS (%)
All Exterior Windows	Window Glazing (2 nd floor)	3
All Exterior Windows	Window glazing (1 st floor)	2-3
~70 Sq. Ft.	Blue 12"x12" VFT	2
~180 Sq. Ft.	Cream 12"x12" VFT	2
~1,600 Sq. Ft.	Dark 9"x9" VFT	3
~1,870 Sq. Ft.	Red 9"x9" VFT	3

3.0 CONCLUSION/RECOMMENDATION

Laboratory analysis of building material samples collected from the 1803 Eoff Street structure positively identified asbestos containing materials. Caution should be exercised when working with these materials. Abatement or encapsulating of these materials should be completed prior to any demolition or remodeling. Such work should be performed by an asbestos abatement contractor, licensed by the State of West Virginia.

Triad Engineering, Inc.




Nathan A. Carte
 Licensed Asbestos Inspector
 West Virginia License #AI008366



John B. Hope
 Licensed Asbestos Inspector
 West Virginia License #A1007558

FIGURES

Plotted by: mdennis
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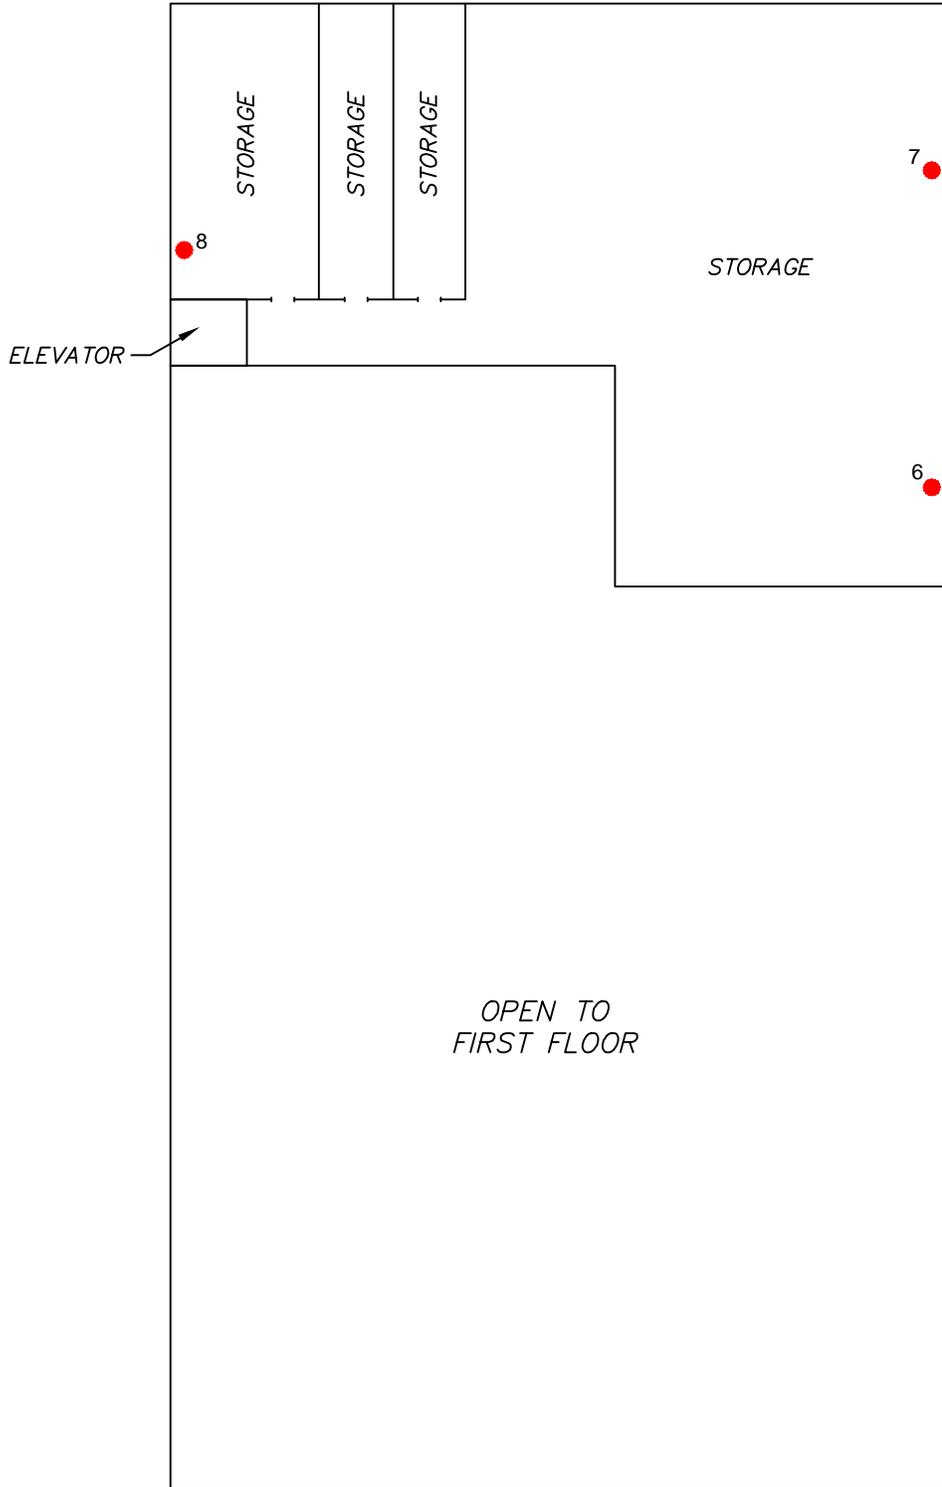
CADD FILE: Wesco asbestos.dwg	
DRAWN BY: RSB	CHECKED BY: HM
DATE: 11/12/2015	SCALE: N.T.S.

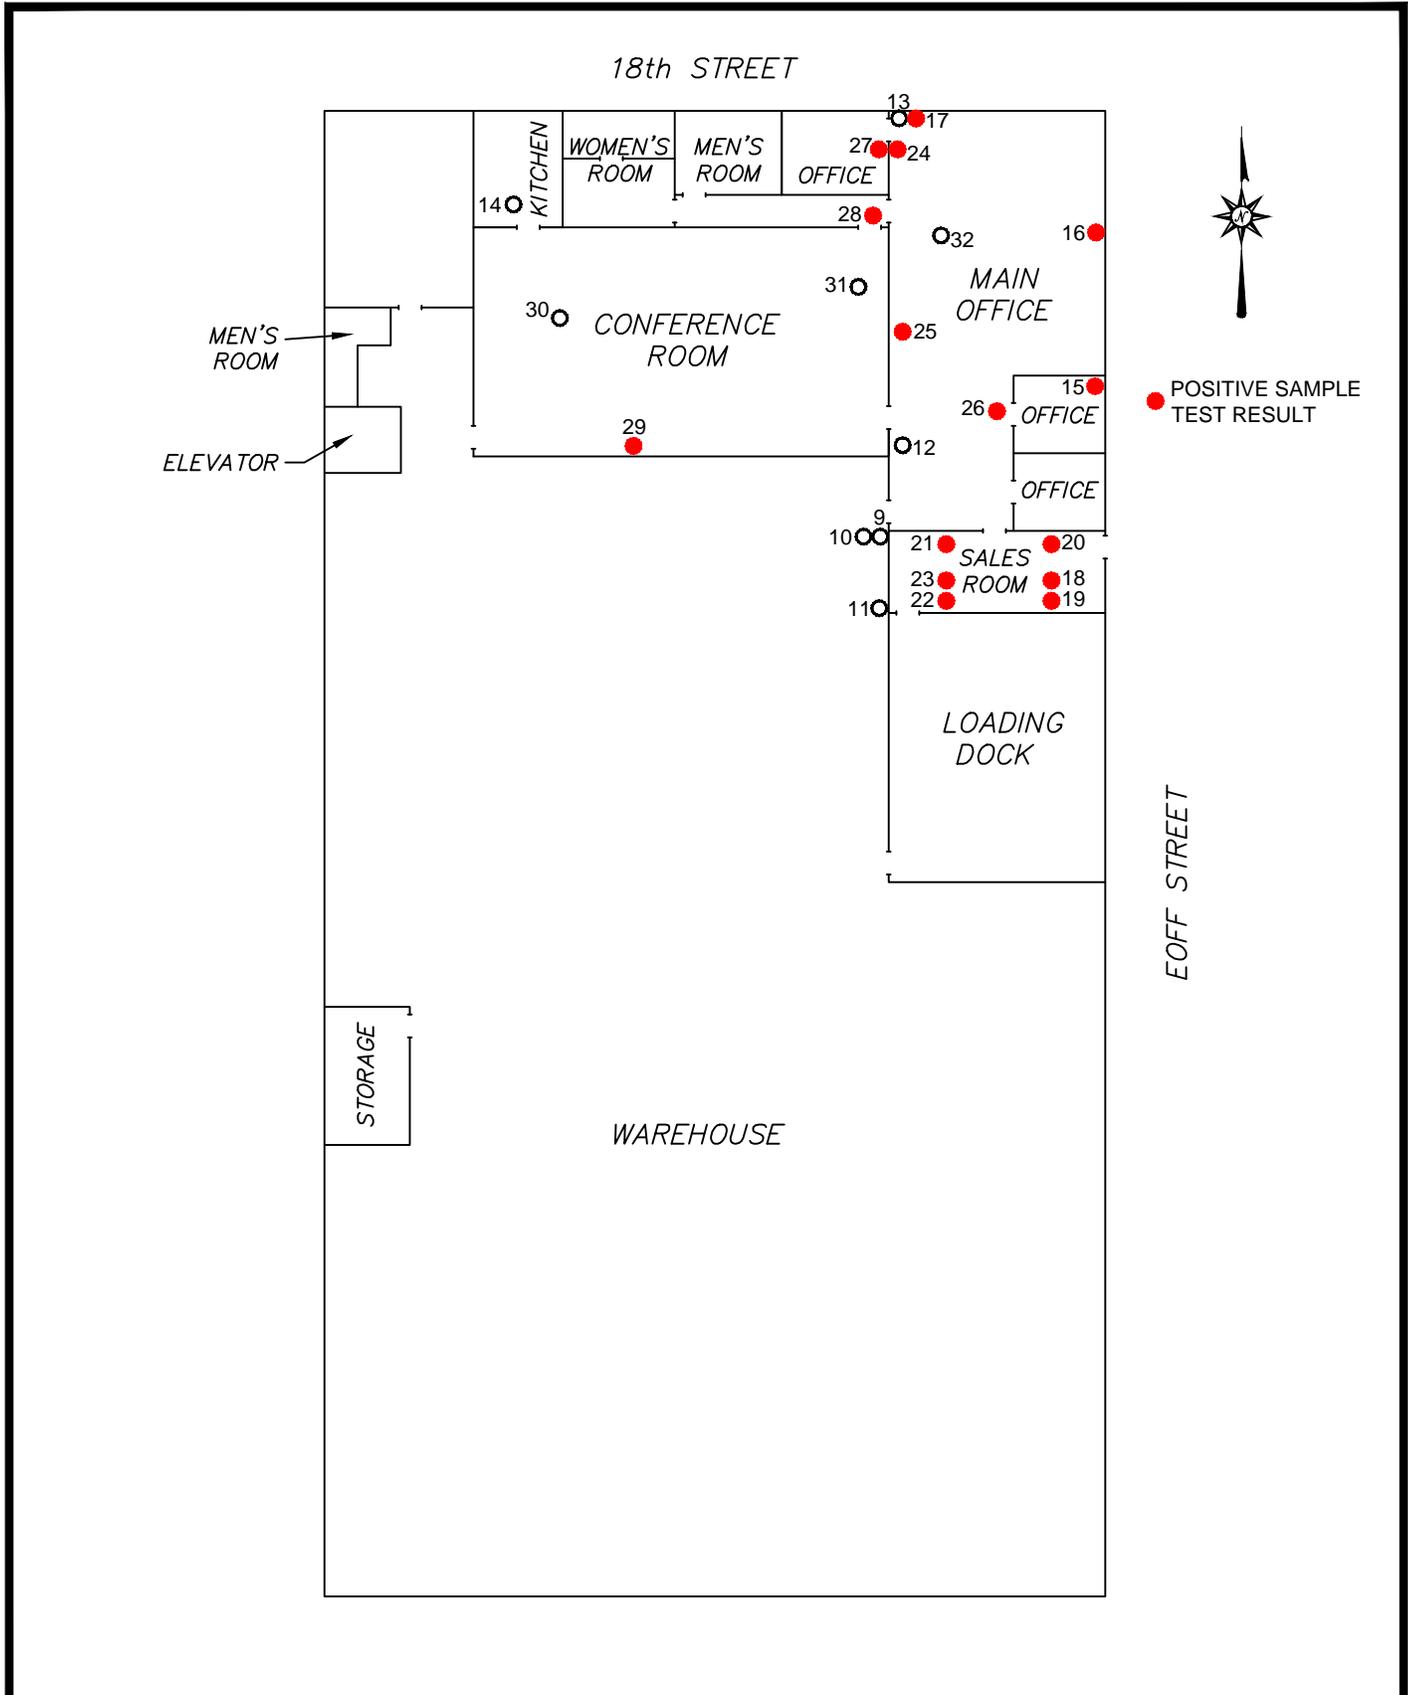FORMER WESCO FACILITY ASBESTOS INSPECTIONS
 1803 EOFF STREET
 WHEELING, OHIO COUNTY, WV
FIRST FLOOR

PROJECT No.: 04-15-0603 FIGURE No.: 1

TRIAD
 TRIAD ENGINEERING, INC.
 www.triadeng.com
 10541 TEAYS VALLEY ROAD
 SCOTT DEPOT, WV 25560

18th STREET



● POSITIVE SAMPLE TEST RESULT

EOFF STREET

OPEN TO FIRST FLOOR


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CADD FILE: Wesco asbestos.dwg	
DRAWN BY: RSB	CHECKED BY: HM
DATE: 11/12/2015	SCALE: N.T.S.

FORMER WESCO FACILITY ASBESTOS INSPECTIONS 1803 EOFF STREET WHEELING, OHIO COUNTY, WV SECOND FLOOR	
PROJECT No.: 04-15-0603	FIGURE No.: 2


TRIAD ENGINEERING, INC.
www.triadeng.com
 10541 TEAYS VALLEY ROAD
 SCOTT DEPOT, WV 25560

18th STREET

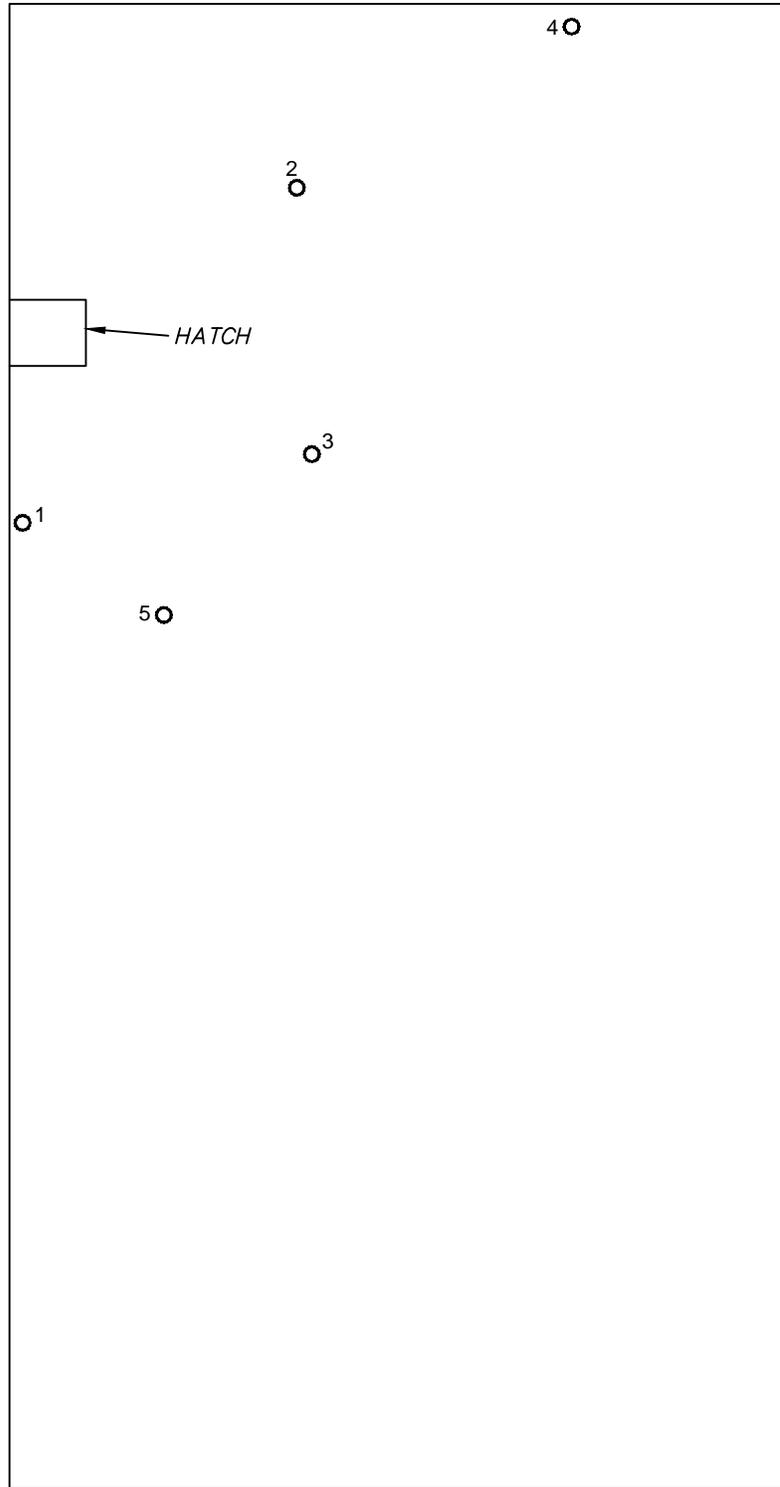

● POSITIVE SAMPLE
TEST RESULT

EOFF STREET

Plotted by: mdennis
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CADD FILE: Wesco asbestos.dwg	
DRAWN BY: RSB	CHECKED BY: HM
DATE: 11/12/2015	SCALE: N.T.S.

FORMER WESCO FACILITY ASBESTOS INSPECTIONS
1803 EOFF STREET
WHEELING, OHIO COUNTY, WV
ROOF

PROJECT No.: 04-15-0603 FIGURE No.: 3

TRIAD
TRIAD ENGINEERING, INC.
www.triadeng.com
10541 TEAYS VALLEY ROAD
SCOTT DEPOT, WV 25560

ATTACHMENT 1
LABORATORY LICENSE

State of West Virginia

Bureau for Public Health
Office of Environmental Health Services
Radiation, Toxics and Indoor Air Division
This is to certify that

Pinnacle Environmental Consultants, Inc.

**400-D Prestige Park
Hurricane, WV 25526**

Has complied with Chapter 16, Article 32, of the Asbestos Abatement Licensing Rules and Regulations and is hereby licensed as an Asbestos Air and Bulk Sample Analytical Laboratory.

Asbestos Laboratory License Number::
LT000499

Issued: **11/25/2014**

Expires: **11/30/2015**



WEST VIRGINIA

Asbestos Program

Pinnacle Environmental
Consultants, Inc.

IS LICENSED AS AN
ASBESTOS LABORATORY -
AIR AND BULK

License #: **LT000499**
Issued: **11/25/2014**
Expires: **11/30/2015**

Walter M. Ivey

Director
WV/OEHS

Walter M. Ivey

Walter M. Ivey, Director
Office of Environmental Health Services

ATTACHMENT 2

LABORATORY ANALYSIS REPORTS

Asbestos Identification by Polarized Light Microscopy

Analysis Report



NVLAP LAB CODE: 200718-0

WV License #: LT000499

Attn: Jobe Hope
Triad Engineering

VA License #: 333 000241

4980 Teays Valley Road
Scott Depot, WV 25560

400-D Prestige Park
Hurricane, West
Virginia 25526
Phone: 304-757-5204
Fax: 304-757-5205

Received Date: 11/10/2015

PEC Project #:

Analysis Date: 11/12/2015

Client Project/PO #: 04-15-0603

RE: Wesco

PEC LAB #:	CLIENT ID #:	LOCATION:	COLOR:
15WB-17505	S-01	Main Roof	Black
Texture/Description:	Solid/Roofing - Rolled	Chrysotile: 0%	Tremolite: 0% Anthophyllite: 0%
TOTAL ASBESTOS:	0 %	Amosite: 0%	Actinolite: 0% Crocidolite: 0%
Cellulose: 2 %	Fiber Glass: 3%	Others: 0%	Filler/Binder: 95 %

PEC LAB #:	CLIENT ID #:	LOCATION:	COLOR:
15WB-17506	S-02	Main Roof	Black
Texture/Description:	Solid/Roofing - Rolled	Chrysotile: 0%	Tremolite: 0% Anthophyllite: 0%
TOTAL ASBESTOS:	0 %	Amosite: 0%	Actinolite: 0% Crocidolite: 0%
Cellulose: 18 %	Fiber Glass: 0%	Others: 0%	Filler/Binder: 82 %

PEC LAB #:	CLIENT ID #:	LOCATION:	COLOR:
15WB-17507	S-03	Main Roof	Black
Texture/Description:	Solid/Roofing - Rolled	Chrysotile: 0%	Tremolite: 0% Anthophyllite: 0%
TOTAL ASBESTOS:	0 %	Amosite: 0%	Actinolite: 0% Crocidolite: 0%
Cellulose: 20 %	Fiber Glass: 0%	Others: 0%	Filler/Binder: 80 %

PEC LAB #:	CLIENT ID #:	LOCATION:	COLOR:
15WB-17508	S-04	Main Roof	Black
Texture/Description:	Solid/Roofing - Rolled	Chrysotile: 0%	Tremolite: 0% Anthophyllite: 0%
TOTAL ASBESTOS:	0 %	Amosite: 0%	Actinolite: 0% Crocidolite: 0%
Cellulose: 2 %	Fiber Glass: 3%	Others: 0%	Filler/Binder: 95 %

PEC LAB #:	CLIENT ID #:	LOCATION:	COLOR:
15WB-17509	S-05	Main Roof	Black
Texture/Description:	Solid/Roofing - Rolled	Chrysotile: 0%	Tremolite: 0% Anthophyllite: 0%
TOTAL ASBESTOS:	0 %	Amosite: 0%	Actinolite: 0% Crocidolite: 0%
Cellulose: 3 %	Fiber Glass: 3%	Others: 0%	Filler/Binder: 94 %

RE: Wesco

PEC LAB #:	CLIENT ID #:	LOCATION:	COLOR:				
15WB-17510	S-06	2nd Floor	Black/Grey				
Texture/Description:	Solid/Window Glazing	Chrysotile:	3%	Tremolite:	0%	Anthophyllite:	0%
TOTAL ASBESTOS:	3 %	Amosite:	0%	Actinolite:	0%	Crocidolite:	0%
Cellulose:	0 %	Fiber Glass:	0%	Others:	0%	Filler/Binder:	97 %

PEC LAB #:	CLIENT ID #:	LOCATION:	COLOR:				
15WB-17511	S-07	2nd Floor	Grey				
Texture/Description:	Solid/Window Glazing	Chrysotile:	3%	Tremolite:	0%	Anthophyllite:	0%
TOTAL ASBESTOS:	3 %	Amosite:	0%	Actinolite:	0%	Crocidolite:	0%
Cellulose:	0 %	Fiber Glass:	0%	Others:	0%	Filler/Binder:	97 %

PEC LAB #:	CLIENT ID #:	LOCATION:	COLOR:				
15WB-17512	S-08	2nd Floor	Grey				
Texture/Description:	Solid/Window Glazing	Chrysotile:	3%	Tremolite:	0%	Anthophyllite:	0%
TOTAL ASBESTOS:	3 %	Amosite:	0%	Actinolite:	0%	Crocidolite:	0%
Cellulose:	0 %	Fiber Glass:	0%	Others:	0%	Filler/Binder:	97 %

PEC LAB #:	CLIENT ID #:	LOCATION:	COLOR:				
15WB-17513	S-09	1st Floor	Grey				
Texture/Description:	Solid/Cement Wall Covering	Chrysotile:	0%	Tremolite:	0%	Anthophyllite:	0%
TOTAL ASBESTOS:	0 %	Amosite:	0%	Actinolite:	0%	Crocidolite:	0%
Cellulose:	0 %	Fiber Glass:	0%	Others:	0%	Filler/Binder:	100%

PEC LAB #:	CLIENT ID #:	LOCATION:	COLOR:				
15WB-17514	S-10	1st Floor	Grey				
Texture/Description:	Solid/Cement Wall Covering	Chrysotile:	0%	Tremolite:	0%	Anthophyllite:	0%
TOTAL ASBESTOS:	0 %	Amosite:	0%	Actinolite:	0%	Crocidolite:	0%
Cellulose:	2 %	Fiber Glass:	0%	Others:	0%	Filler/Binder:	98 %

PEC LAB #:	CLIENT ID #:	LOCATION:	COLOR:				
15WB-17515	S-11	1st Floor	Grey				
Texture/Description:	Solid/Cement Wall Covering	Chrysotile:	0%	Tremolite:	0%	Anthophyllite:	0%
TOTAL ASBESTOS:	0 %	Amosite:	0%	Actinolite:	0%	Crocidolite:	0%
Cellulose:	0 %	Fiber Glass:	0%	Others:	0%	Filler/Binder:	100%

PEC LAB #:	CLIENT ID #:	LOCATION:	COLOR:				
15WB-17516a	S-12	1st Floor	Beige				
Texture/Description:	Solid/Wall Plaster	Chrysotile:	0%	Tremolite:	0%	Anthophyllite:	0%
TOTAL ASBESTOS:	0 %	Amosite:	0%	Actinolite:	0%	Crocidolite:	0%
Cellulose:	2 %	Fiber Glass:	0%	Others:	0%	Filler/Binder:	98 %

RE: Wesco

PEC LAB #:	CLIENT ID #:	LOCATION:	COLOR:
15WB-17516b	S-12	1st Floor	White
Texture/Description:	Solid/Top Coat	Chrysotile: 0%	Tremolite: 0% Anthophyllite: 0%
TOTAL ASBESTOS:	0 %	Amosite: 0%	Actinolite: 0% Crocidolite: 0%
Cellulose: 0 %	Fiber Glass: 0%	Others: 0%	Filler/Binder: 100%

PEC LAB #:	CLIENT ID #:	LOCATION:	COLOR:
15WB-17517	S-13	1st Floor	White
Texture/Description:	Solid/Wall Plaster	Chrysotile: 0%	Tremolite: 0% Anthophyllite: 0%
TOTAL ASBESTOS:	0 %	Amosite: 0%	Actinolite: 0% Crocidolite: 0%
Cellulose: 0 %	Fiber Glass: 0%	Others: 0%	Filler/Binder: 100%

PEC LAB #:	CLIENT ID #:	LOCATION:	COLOR:
15WB-17518a	S-14	1st Floor	Beige
Texture/Description:	Solid/Wall Plaster	Chrysotile: 0%	Tremolite: 0% Anthophyllite: 0%
TOTAL ASBESTOS:	0 %	Amosite: 0%	Actinolite: 0% Crocidolite: 0%
Cellulose: 0 %	Fiber Glass: 0%	Others: 2%	Filler/Binder: 98 %

PEC LAB #:	CLIENT ID #:	LOCATION:	COLOR:
15WB-17518b	S-14	1st Floor	White
Texture/Description:	Solid/Top Coat	Chrysotile: 0%	Tremolite: 0% Anthophyllite: 0%
TOTAL ASBESTOS:	0 %	Amosite: 0%	Actinolite: 0% Crocidolite: 0%
Cellulose: 2 %	Fiber Glass: 0%	Others: 0%	Filler/Binder: 98 %

PEC LAB #:	CLIENT ID #:	LOCATION:	COLOR:
15WB-17519	S-15	1st Floor	White/Grey
Texture/Description:	Solid/Window Glazing	Chrysotile: 3%	Tremolite: 0% Anthophyllite: 0%
TOTAL ASBESTOS:	3 %	Amosite: 0%	Actinolite: 0% Crocidolite: 0%
Cellulose: 0 %	Fiber Glass: 0%	Others: 0%	Filler/Binder: 97 %

PEC LAB #:	CLIENT ID #:	LOCATION:	COLOR:
15WB-17520	S-16	1st Floor	White/Grey
Texture/Description:	Solid/Window Glazing	Chrysotile: 2%	Tremolite: 0% Anthophyllite: 0%
TOTAL ASBESTOS:	2 %	Amosite: 0%	Actinolite: 0% Crocidolite: 0%
Cellulose: 0 %	Fiber Glass: 0%	Others: 0%	Filler/Binder: 98 %

PEC LAB #:	CLIENT ID #:	LOCATION:	COLOR:
15WB-17521	S-17	1st Floor	White/Grey
Texture/Description:	Solid/Window Glazing	Chrysotile: 2%	Tremolite: 0% Anthophyllite: 0%
TOTAL ASBESTOS:	2 %	Amosite: 0%	Actinolite: 0% Crocidolite: 0%
Cellulose: 0 %	Fiber Glass: 0%	Others: 0%	Filler/Binder: 98 %

RE: Wesco

PEC LAB #:	CLIENT ID #:	LOCATION:	COLOR:			
15WB-17522a	S-18	1st Floor	Blue			
Texture/Description:	Solid/12x12 Floor Tile	Chrysotile: 2%	Tremolite: 0%	Anthophyllite: 0%		
TOTAL ASBESTOS:	2 %	Amosite: 0%	Actinolite: 0%	Crocidolite: 0%		
Cellulose: 0 %	Fiber Glass: 0%	Others: 0%	Filler/Binder: 98 %			

PEC LAB #:	CLIENT ID #:	LOCATION:	COLOR:			
15WB-17522b	S-18	1st Floor	Black			
Texture/Description:	Solid/Mastic	Chrysotile: 2%	Tremolite: 0%	Anthophyllite: 0%		
TOTAL ASBESTOS:	2 %	Amosite: 0%	Actinolite: 0%	Crocidolite: 0%		
Cellulose: 2 %	Fiber Glass: 0%	Others: 0%	Filler/Binder: 96 %			

PEC LAB #:	CLIENT ID #:	LOCATION:	COLOR:			
15WB-17523a	S-19	1st Floor	Blue			
Texture/Description:	Solid/12x12 Floor Tile	Chrysotile: 2%	Tremolite: 0%	Anthophyllite: 0%		
TOTAL ASBESTOS:	2 %	Amosite: 0%	Actinolite: 0%	Crocidolite: 0%		
Cellulose: 0 %	Fiber Glass: 0%	Others: 0%	Filler/Binder: 98 %			

PEC LAB #:	CLIENT ID #:	LOCATION:	COLOR:			
15WB-17523b	S-19	1st Floor	Black			
Texture/Description:	Solid/Mastic	Chrysotile: 2%	Tremolite: 0%	Anthophyllite: 0%		
TOTAL ASBESTOS:	2 %	Amosite: 0%	Actinolite: 0%	Crocidolite: 0%		
Cellulose: 0 %	Fiber Glass: 0%	Others: 0%	Filler/Binder: 98 %			

PEC LAB #:	CLIENT ID #:	LOCATION:	COLOR:			
15WB-17524a	S-20	1st Floor	Blue			
Texture/Description:	Solid/12x12 Floor Tile	Chrysotile: 2%	Tremolite: 0%	Anthophyllite: 0%		
TOTAL ASBESTOS:	2 %	Amosite: 0%	Actinolite: 0%	Crocidolite: 0%		
Cellulose: 0 %	Fiber Glass: 0%	Others: 0%	Filler/Binder: 98 %			

PEC LAB #:	CLIENT ID #:	LOCATION:	COLOR:			
15WB-17524b	S-20	1st Floor	Black			
Texture/Description:	Solid/Mastic	Chrysotile: 2%	Tremolite: 0%	Anthophyllite: 0%		
TOTAL ASBESTOS:	2 %	Amosite: 0%	Actinolite: 0%	Crocidolite: 0%		
Cellulose: 2 %	Fiber Glass: 0%	Others: 0%	Filler/Binder: 96 %			

PEC LAB #:	CLIENT ID #:	LOCATION:	COLOR:			
15WB-17525a	S-21	1st Floor	Cream			
Texture/Description:	Solid/12x12 Floor Tile	Chrysotile: 2%	Tremolite: 0%	Anthophyllite: 0%		
TOTAL ASBESTOS:	2 %	Amosite: 0%	Actinolite: 0%	Crocidolite: 0%		
Cellulose: 0 %	Fiber Glass: 0%	Others: 0%	Filler/Binder: 98 %			

RE: Wesco

PEC LAB #:	CLIENT ID #:	LOCATION:	COLOR:
15WB-17525b	S-21	1st Floor	Black
Texture/Description:	Solid/Mastic	Chrysotile: 2%	Tremolite: 0% Anthophyllite: 0%
TOTAL ASBESTOS:	2 %	Amosite: 0%	Actinolite: 0% Crocidolite: 0%
Cellulose: 0 %	Fiber Glass: 0%	Others: 0%	Filler/Binder: 98 %

PEC LAB #:	CLIENT ID #:	LOCATION:	COLOR:
15WB-17526a	S-22	1st Floor	Cream
Texture/Description:	Solid/12x12 Floor Tile	Chrysotile: 2%	Tremolite: 0% Anthophyllite: 0%
TOTAL ASBESTOS:	2 %	Amosite: 0%	Actinolite: 0% Crocidolite: 0%
Cellulose: 0 %	Fiber Glass: 0%	Others: 0%	Filler/Binder: 98 %

PEC LAB #:	CLIENT ID #:	LOCATION:	COLOR:
15WB-17526b	S-22	1st Floor	Black
Texture/Description:	Solid/Mastic	Chrysotile: 2%	Tremolite: 0% Anthophyllite: 0%
TOTAL ASBESTOS:	2 %	Amosite: 0%	Actinolite: 0% Crocidolite: 0%
Cellulose: 2 %	Fiber Glass: 0%	Others: 0%	Filler/Binder: 96 %

PEC LAB #:	CLIENT ID #:	LOCATION:	COLOR:
15WB-17527a	S-23	1st Floor	Cream
Texture/Description:	Solid/12x12 Floor Tile	Chrysotile: 2%	Tremolite: 0% Anthophyllite: 0%
TOTAL ASBESTOS:	2 %	Amosite: 0%	Actinolite: 0% Crocidolite: 0%
Cellulose: 0 %	Fiber Glass: 0%	Others: 0%	Filler/Binder: 98 %

PEC LAB #:	CLIENT ID #:	LOCATION:	COLOR:
15WB-17527b	S-23	1st Floor	Black
Texture/Description:	Solid/Mastic	Chrysotile: 2%	Tremolite: 0% Anthophyllite: 0%
TOTAL ASBESTOS:	2 %	Amosite: 0%	Actinolite: 0% Crocidolite: 0%
Cellulose: 2 %	Fiber Glass: 0%	Others: 0%	Filler/Binder: 96 %

PEC LAB #:	CLIENT ID #:	LOCATION:	COLOR:
15WB-17528a	S-24	1st Floor	Brown
Texture/Description:	Solid/9x9 Floor Tile	Chrysotile: 3%	Tremolite: 0% Anthophyllite: 0%
TOTAL ASBESTOS:	3 %	Amosite: 0%	Actinolite: 0% Crocidolite: 0%
Cellulose: 0 %	Fiber Glass: 0%	Others: 0%	Filler/Binder: 97 %

PEC LAB #:	CLIENT ID #:	LOCATION:	COLOR:
15WB-17528b	S-24	1st Floor	Black
Texture/Description:	Solid/Mastic	Chrysotile: 0%	Tremolite: 0% Anthophyllite: 0%
TOTAL ASBESTOS:	0 %	Amosite: 0%	Actinolite: 0% Crocidolite: 0%
Cellulose: 2 %	Fiber Glass: 0%	Others: 0%	Filler/Binder: 98 %

RE: Wesco

PEC LAB #:	CLIENT ID #:	LOCATION:	COLOR:			
15WB-17529a	S-25	1st Floor	Brown			
Texture/Description:	Solid/9x9 Floor Tile		Chrysotile: 3%	Tremolite: 0%	Anthophyllite: 0%	
TOTAL ASBESTOS:	3 %		Amosite: 0%	Actinolite: 0%	Crocidolite: 0%	
Cellulose: 0 %	Fiber Glass: 0%		Others: 0%	Filler/Binder: 97 %		

PEC LAB #:	CLIENT ID #:	LOCATION:	COLOR:			
15WB-17529b	S-25	1st Floor	Black			
Texture/Description:	Solid/Mastic		Chrysotile: 0%	Tremolite: 0%	Anthophyllite: 0%	
TOTAL ASBESTOS:	0 %		Amosite: 0%	Actinolite: 0%	Crocidolite: 0%	
Cellulose: 2 %	Fiber Glass: 0%		Others: 0%	Filler/Binder: 98 %		

PEC LAB #:	CLIENT ID #:	LOCATION:	COLOR:			
15WB-17530	S-26	1st Floor	Brown			
Texture/Description:	Solid/9x9 Floor Tile		Chrysotile: 3%	Tremolite: 0%	Anthophyllite: 0%	
TOTAL ASBESTOS:	3 %		Amosite: 0%	Actinolite: 0%	Crocidolite: 0%	
Cellulose: 0 %	Fiber Glass: 0%		Others: 0%	Filler/Binder: 97 %		

PEC LAB #:	CLIENT ID #:	LOCATION:	COLOR:			
15WB-17531a	S-27	1st Floor	Red			
Texture/Description:	Solid/9x9 Floor Tile		Chrysotile: 3%	Tremolite: 0%	Anthophyllite: 0%	
TOTAL ASBESTOS:	3 %		Amosite: 0%	Actinolite: 0%	Crocidolite: 0%	
Cellulose: 0 %	Fiber Glass: 0%		Others: 0%	Filler/Binder: 97 %		

PEC LAB #:	CLIENT ID #:	LOCATION:	COLOR:			
15WB-17531b	S-27	1st Floor	Black			
Texture/Description:	Solid/Mastic		Chrysotile: 0%	Tremolite: 0%	Anthophyllite: 0%	
TOTAL ASBESTOS:	0 %		Amosite: 0%	Actinolite: 0%	Crocidolite: 0%	
Cellulose: 2 %	Fiber Glass: 0%		Others: 0%	Filler/Binder: 98 %		

PEC LAB #:	CLIENT ID #:	LOCATION:	COLOR:			
15WB-17532a	S-28	1st Floor	Red			
Texture/Description:	Solid/9x9 Floor Tile		Chrysotile: 3%	Tremolite: 0%	Anthophyllite: 0%	
TOTAL ASBESTOS:	3 %		Amosite: 0%	Actinolite: 0%	Crocidolite: 0%	
Cellulose: 0 %	Fiber Glass: 0%		Others: 0%	Filler/Binder: 97 %		

PEC LAB #:	CLIENT ID #:	LOCATION:	COLOR:			
15WB-17532b	S-28	1st Floor	Black			
Texture/Description:	Solid/Mastic		Chrysotile: 0%	Tremolite: 0%	Anthophyllite: 0%	
TOTAL ASBESTOS:	0 %		Amosite: 0%	Actinolite: 0%	Crocidolite: 0%	
Cellulose: 2 %	Fiber Glass: 0%		Others: 0%	Filler/Binder: 98 %		

Project # <u>04-15-0603</u>	Date <u>11/9/15</u>	Results To: <u>Jobe Hope, jhope@triadeng.com</u>
Project Name: <u>WESCO</u>		Triad Engineering, Inc. 10541 Teays Valley Rd. Scott Depot, WV 25560 PH 304-755-0721 fax 304-755-1880
Parcel # <u>Wheeling</u>	Turnaround time STD <u>24hr</u> (48hr) <u>72hr</u>	Page <u>1</u> of <u>2</u>

ASBESTOS SAMPLE TABLE and CHAIN OF CUSTODY

LAB NO.	SAMPLE NO.	MATERIAL	HOMO-GENOUS AREA	LOCATION	ASBESTOS PLM
15WB-17505	S-01	Roofing - Rolled	01	Main Roof	
	S-02	↓	↓	↓	
	S-03				
	S-04				
	S-05	↓	↓	↓	
	S-06	Window Glazing	02	2nd Floor	
	S-07	↓	↓	↓	
	S-08				
	S-09	Cement wall covering	03	1st Floor	
	S-10	↓	↓	↓	
	S-11				
	S-12	Wall Plaster	04	1st Floor	
	S-13				
	S-14				
	S-15	Window Glazing	05	1st Floor	
	S-16	↓	↓		
	S-17				
	S-18	Floor tile - Blue 12x12	06	1st Floor	
	S-19	↓	↓	↓	
	S-20				
	S-21	Floor tile - Cream 12x12	07	1st Floor	
	S-22	↓	↓	↓	
	S-23				
	S-24	Floor tile Dark	08	1st Floor	
	S-25	9x9 tile			
15WB-17530	S-26	↓	↓	↓	

Collected/Relinquished by [Signature]
Date and Time 11.10.15 11:11

Received By [Signature]

ATTACHEMENT 3
SITE PHOTOGRAPHS



Photograph # 1
View of western side of site structure.



Photograph # 2
View of northern side of site structure.



Photograph # 3
View of eastern side of site structure.



Photograph # 4
View of southern side of site structure.



Photograph # 5
Roofing samples 1, 2, 3, 4 & 5.




Photograph # 6
2nd floor window glazing samples 6, 7 & 8.



Photograph # 7
Cement wall covering samples 9, 10 & 11.



Photograph # 8
Wall plaster samples 12, 13 & 14.

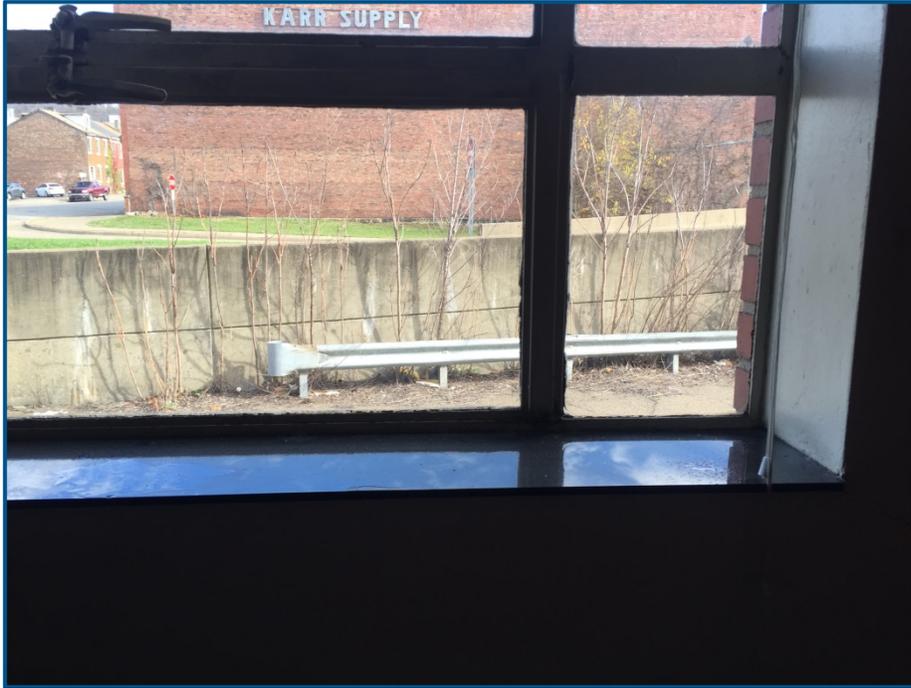

Photograph # 9
1st floor window glazing samples 15, 16 & 17.



Photograph # 10
Blue and cream colored floor tile samples 18, 19, 20, 21, 22 & 23.



Photograph # 11
Dark 9"x 9" floor tile samples 24, 25 & 26.



Photograph # 12
Red 9"x 9" floor tile samples 27, 28 & 29.



Photograph # 13
Acoustic ceiling tile samples 30, 31 & 32.

ATTACHMENT 4

INSPECTOR LICENSE AND CERTIFICATION

This Certificate is Awarded to

Nathan Carte

Who has successfully completed the below course with a score of 70% or better. This course is West Virginia and EPA approved and meets the requirements set forth in 40 CFR Part 763 (AHERA) for purposes of accreditation required under TSCA Title II. This Course was conducted by Astar Abatement, Incorporated.

Asbestos Inspector Initial

Course Start Date
4/7/2015

Exam Date
4/9/2015
Expiration Date
4/9/2016

Total Hours
24

Certificate Number
AI13107-1011



Donald P. Morris
Instructors Name

Donald P. Morris
Instructors Signature

Post Office Box 13533
Sissonville, WV 25360
Phone: (304) 343-5950
Fax: (304) 343-5961

There is a printed watermark below the Instructors signature on the original



License # AI008366
Issued: 8/10/2015
Expires: 8/31/2016

Nathan Carte

Director
WV OEHS

IS LICENSED AS AN
ASBESTOS INSPECTOR

WEST VIRGINIA
Asbestos Program
Nathan Carte



WEST VIRGINIA

Asbestos Program

John B. Hope

IS LICENSED AS AN
ASBESTOS INSPECTOR

License #: AI008048

Issued: 12/16/2014

Expires: 12/31/2015

Walter M. Drey

Director
WV OEHS